

PLAN SCALE 1:50

**VARIES** 

SECTION

MANHOLE TYPE D


1m ≤ DEPTH TO INVERT < 3m

1425

**ROOF PLAN** 

FLOW DIRECT

SCALE 1:50

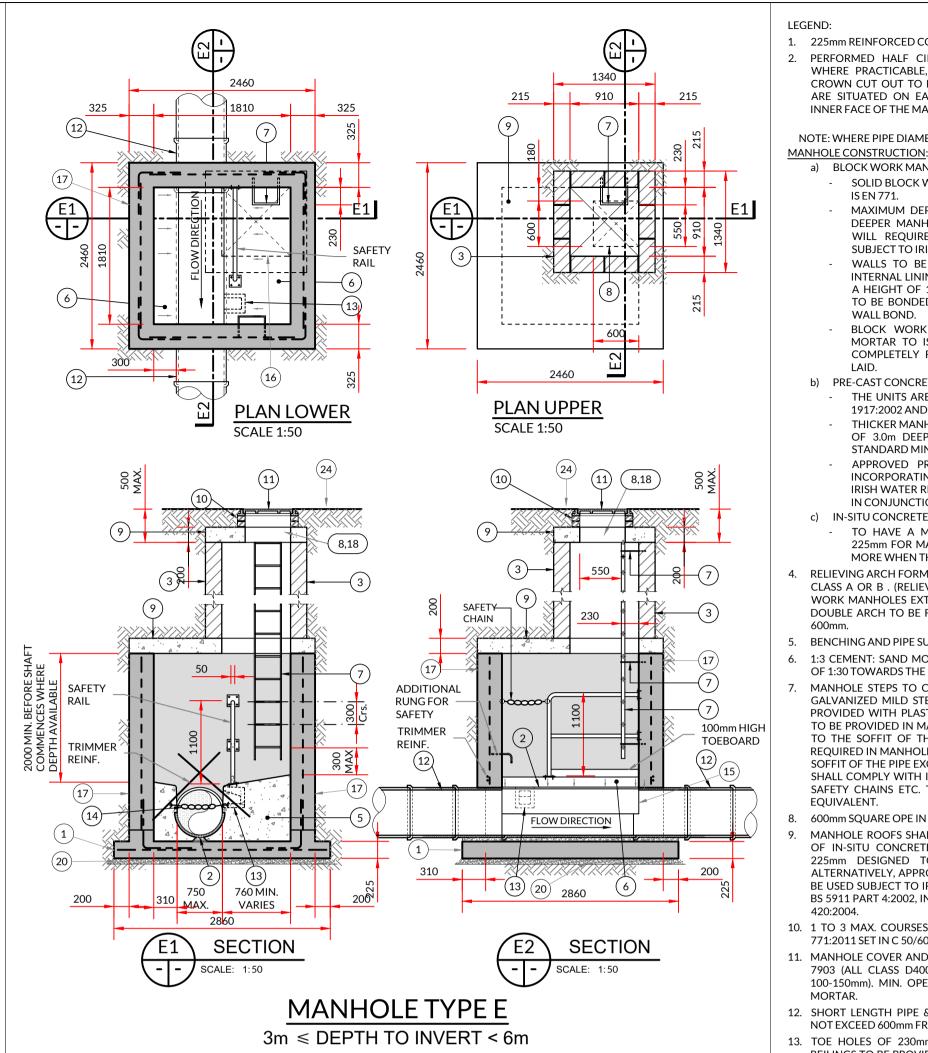

c) IN-SITU CONCRETE MANHOLE: RELIEVING ARCH FORMED BY 215x103x65 SOLID ENGINEERING BRICK CLASS A OR B. (RELIEVING ARCHES ARE USED IN BRICK OR BLOCK WORK MANHOLES EXTENDED OVER FULL THICKNESS OF WALLS). A DOUBLE ARCH TO BE FORMED FOR PIPE DIAMETER GREATER THAN BENCHING AND PIPE SURROUND - C30/37 CONCRETE. 6. 1:3 CEMENT: SAND MORTAR WITH STEEL TROWEL FINISH AT SLOPE OF 1:30 TOWARDS THE CHANNEL MANHOLE STEPS TO COMPLY WITH IS EN 13101, TYPE D, CLASS 1. GALVANIZED MILD STEEL STEP RUNGS, 20mm DIAMETER, SHALL BE PROVIDED WITH PLASTIC ENCAPSULATED FINISH. STEP RUNGS ARE TO BE PROVIDED IN MANHOLES WHERE THE DEPTH FROM GROUND TO THE SOFFIT OF THE PIPE IS UP TO 3.0m. FIXED LADDERS ARE REQUIRED IN MANHOLES WHERE THE DEPTH FROM GROUND TO THE SOFFIT OF THE PIPE EXCEEDS A DEPTH OF 3.0m AND UP TO 6.0m, AND SHALL COMPLY WITH IS EN 14396. ALL LADDER RUNGS, HANDRAILS, SAFETY CHAINS ETC. TO COMPLY WITH BS EN ISO 1461:2009 OR 600mm SQUARE OPE IN ROOF. MANHOLE ROOFS SHALL CONSIST OF REINFORCED CONCRETE SLAB OF IN-SITU CONCRETE 30/37, WITH A MINIMUM THICKNESS OF 225mm DESIGNED TO CARRY ALL LIVE AND DEAD LOADS. ALTERNATIVELY, APPROVED PRE-CAST CONCRETE ROOF SLABS MAY BE USED SUBJECT TO IRISH WATER REVIEW AND COMPLIANCE WITH BS 5911 PART 4:2002, IN CONJUNCTION WITH IS EN 1979:2002 AND IS 10. 1 TO 3 MAX. COURSES OF CLASS B ENGINEERING BRICKS TO IS EN 771:2011 SET IN C 50/60 MORTAR. 11. MANHOLE COVER AND FRAME SHALL COMPLY TO IS EN 124 AND BS 7903 (ALL CLASS D400 COVERS SHALL HAVE MIN. FRAME DEPTH 100-150mm). MIN. OPE 600x600mm. COVER TO BE SET IN C 50/60 12. SHORT LENGTH PIPE & PIPE JOINT EXTERNAL TO MAHOLES SHALL NOT EXCEED 600mm FROM THE INNER FACE OF THE MANHOLE WALL. 13. TOE HOLES OF 230mm MINIMUM DEPTH & GALVANIZED SAFETY REILINGS TO BE PROVIDED IN BENCHING OF SEWERS GREATER THAN 525mm Ø & DEPTH TO INVERT> 3.0m FOR ACCESS TO INVERT. 14. STAINLESS STEEL CHAIN IS TO BE PROVIDED ON PIPES THAT EXCEEDED 450mm Ø, COMPLYING WITH BS4942 PART 2 OR

LEGEND:

1. 225mm REINFORCED CONCRETE BASE, GRADE 30/37.

SUBJECT TO IRISH WATER REVIEW)

NOTE: WHERE PIPE DIAMETER CHANGES A MANHOLE, PIPE TO LINE UP

SOLID BLOCK WORK TO BE OF HIGH STRENGTH (20N/mm<sup>2</sup>) TO

MAXIMUM DEPTH IS 1.20m (THE USE OF BLOCK WORK IN

DEEPER MANHOLES WILL BE CONSIDERED BUT SUCH USE

WILL REQUIRE DETAILED STRUCTURAL DESIGN AND BE

WALLS TO BE FLUSH AND NOT PLASTERED INTERNALLY,

INTERNAL LINING OF ENGINEERING BRICK TO IS EN 771-1 TO

A HEIGHT OF 1.0m ABOVE BENCHING. ENGINEERING BRICK TO BE BONDED TO BLOCK WORK USING ENGLISH GARDEN

BLOCK WORK SHALL BE EMBEDDED & JOINTED USING

MORTAR TO IS EN 998. BEDS & VERTICAL JOINTS TO BE COMPLETELY FILLED WITH MORTAR AS THE BLOCKS ARE

THE UNITS ARE TO COMPLY WITH REQUIREMENTS OF IS EN

THICKER MANHOLE BASES REQUIRED FOR SEWERS IN EXCESS

OF 3.0m DEEP WHERE THE SIZE IS GREATER THAN THE

APPROVED PRE-CAST CONCRETE BASES MAY BE USED

INCORPORATING CHANNELS, BENCHING ETC. SUBJECT TO

TO HAVE A MINIMUM WALL AND FLOOR THICKNESS OF

225mm FOR MANHOLE DEPTHS UP TO 3.0m AND 300mm OR

MORE WHEN THE MANHOLE DEPTHS EXCEEDS 3.0m.

IRISH WATER REVIEW AND COMPLYING WITH BS 5911-4:2002

INNER FACE OF THE MANHOLE WALL.

b) PRE-CAST CONCRETE MANHOLE:

1917:2002 AND BS 5911-PART 3.

IN CONJUNCTION WITH IS EN 1917:2002.

STANDARD MINIMUM SIZE.

a) BLOCK WORK MANHOLE:

MANHOLE WALLS SO THAT CHANNEL EXTENDS THE FULL LENGTH OF 2. PERFORMED HALF CIRCLE CHANNEL PIPES, THE PIPELINE MAY, 16. POSITION OF 910 SQUARE OPE IN INTERMEDIATE ROOF SLABS: WHERE PRACTICABLE, BE LAID THROUGH THE MANHOLE & THE CROWN CUT OUT TO HALF DIAMETER, PROVIDED FLEXIBLE JOINTS ARE SITUATED ON EACH SIDE NO FURTHER THAN 600mm FROM

a. ALL MANHOLES SHALL BE WATERTIGHT TO THE

SATISFACTION OF THE ENGINEER.

b. FORMWORK TO REINFORCED CONCRETE & MASS CONCRETE SHALL COMPLY WITH IS EN 1992-1-1.

15. PIPE SHOULD BE CUT FLUSH WITH THE INSIDE SURFACE OF THE

FINISH TO THE TOP OF SLAB SHALL COMPLY WITH TYPE A SECTION 6.2.7, BS 8110 PART 1:1997.

d. PLAN DIMENSIONS OF MANHOLES ARE BASED ON BLOCK WORK HAVING A CO-ORDINATING SIZE OF 450x225x100.

FORT PIPE DIAMETER OF > 750mm USE MANHOLE WITH

INTERNAL DIAMETER SIZE = PIPE SIZE +1.0m +300mm. MANHOLES ARE DESIGNED TO BS EN 752:2017 & WALL THICKNESS TO IS EN 1996-1-1, BLOCK WORK DESIGN CODE

TAKING GRANULAR FILL PRESSURE & H.B. SURCHARGE. f. REINFORCEMENTS TO SLABS TO ENGINEERS DETAILS.

17. FOR MANHOLES > 3m DEPTH TO INVERT USE C30/37 IN-SITU CONCRETE, REINFORCING MESH REF. A393 TO BE FIXED AT MID POINT OF WALL. ADDITIONAL REINFORCEMENT TO BE SUPPLIED

18. PRECAST MANHOLES, CHAMBER WALLS & COVER SL,AB TO BE CONSTRUCTED TO IS EN 1917 & IS 420:2004.

19. MANHOLE OPENINGS TO BE SITUATED FURTHEST FROM THE NEAREST CARRIAGEWAY. MANHOLE STEPS-ACCESS TO BE POSITIONED TO ALLOW VIEWING OF ONCOMING TRAFFIC.

20. FOR BEDDING AND CEILING OF CHAMBER RINGS, THE TOP RING (TO PRECAST OVER SLAB) & BOTTOM RING TO BE BEDDED WITH CEMENT MORTAR. FOR INTERMEDIATE RINGS. JOINTS TO BE SEALED WITH APPROVED PREFORMED JOINTING STRAP.

21. PRECAST MANHOLES TO BE SURROUNDED WITH A MINIMUM OF 150mm THICK GRADE C16/20 CONCRETE.

22. 225mm GRADE C 25/30 CONCRETE SURROUND. 23. 75mm GRADE C 12/15 BLINDING CONCRETE.

24. ANY SPECIAL ROAD REINSTATEMENT AROUND COVER AND FRAME SHALL BE TO ROAD AUTHORITY'S REQUIREMENTS, NEW ROAD CONSTRUCTION AND SURFACE FINISH TO BE ROAD AUTHORITY'S REQUIREMENTS. EXISTING ROAD REINSTATEMENT TO COMPLY WITH CURRENT VERSION OF "GUIDELINE FOR MANAGING OPENINGS IN PUBLLIC ROADS" BY THE DEPT. OF TRANSPORT, TOURISM & SPORT,

OR TRANSPORT INFRASTRUCTURE IRELAND REQUIREMENTS. 25. PRECAST CONCRETE MANHOLE RINGS TO IS 420 IN CONJUNCTION WITH EN 1917:2004.

ALL FOUL MANHOLES TO COMPLY WITH REQUIREMENTS OF IRISH WATER STD-WW-09 TO 13.

FIGURED DIMENSIONS ONLY TO BE TAKEN FROM THIS DRAWING

ALL DRAWINGS TO BE CHECKED BY THE

**CONTRACTOR ON SITE** ENGINEER/EMPLOYERS REPRESENTATIVE, AS APPROPRIATE, TO BE INFORMED BY THE CONTRACTOR OF ANY DISCREPANCIES

BEFORE ANY WORK COMMENCES THE CONTRACTOR SHALL UNDERTAKE A THOROUGH CHECK FOR THE ACTUAL

LOCATION OF ALL SERVICES/UTILITIES, ABOVE AND BELOW GROUND, BEFORE ANY WORK COMMENCES

ALL LEVELS SHOWN RELATE TO ORDNANCE SURVEY DATUM AT MALIN HEAD

MANHOLE DETAILS FOR FOUL SEWER TO BE IN ACCORDANCE WITH IRISH WATER STANDARD DETAILS AND CODE OF PRACTICE - IRISH WATER DETAILS & REQUIREMENTS WILL

TAKE PRECEDENCE D01 12/07/202 Draft Planning Date Description By Chkd.

Galway County Council


**Proposed Residential Development** Baile an Chlair Claregalway


Standard Manhole Details. Sheet 1 of 2




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Drawing No.: 11171-2017 D01



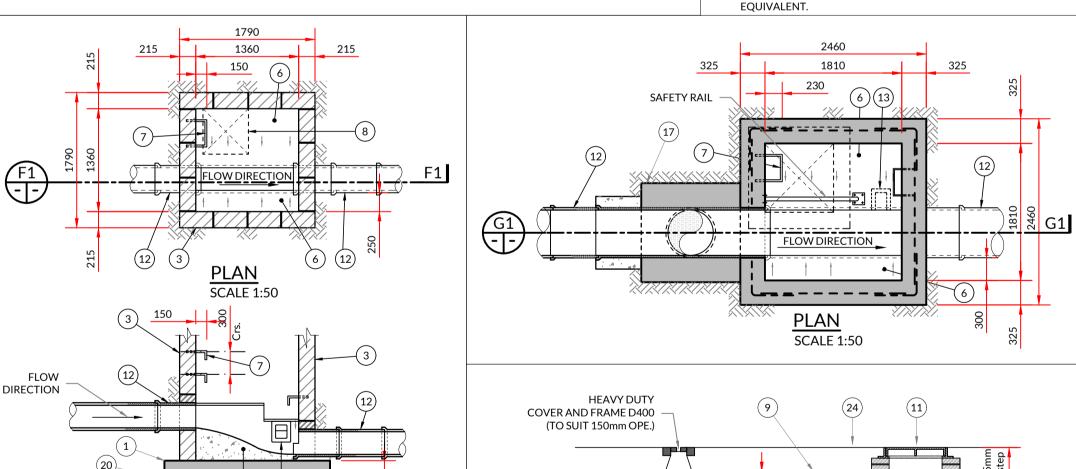

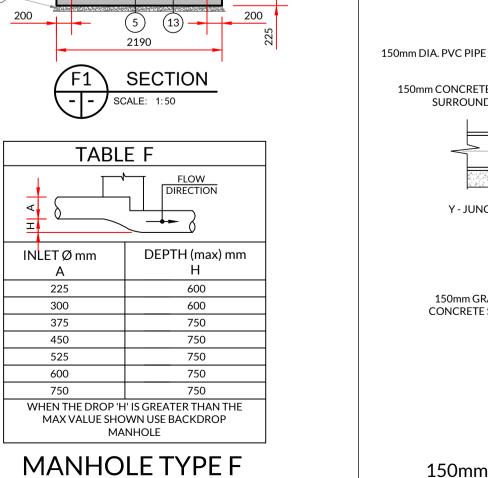**RAMP MANHOLE** 

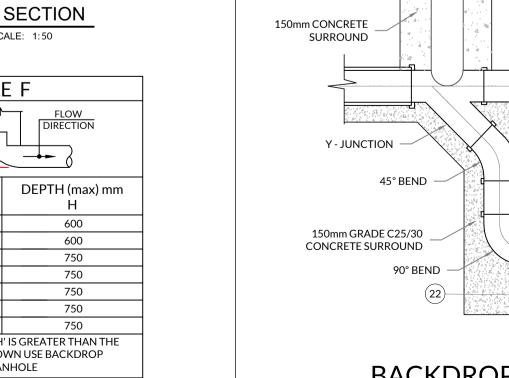

**BACKDROP MAHOLE TYPE G.1** 

150mm - 450mm DIA. (INCL.) DROP GREATER THAN 1700mm 500mm - 900mm DIA. (INCL.) DROP GREATER THAN 2300mm

NOT TO SCALE

STOPPER